NOT TO SCALE NOT TO SCALE Richard Breatley De Richard Richard Breatley De Richard Richar


CONSTRUCTION DRAWINGS FOR

PACIFIC PLACE


LOCATED IN CITY OF WILMINGTON NEW HANOVER COUNTY, NORTH CAROLINA

GENERAL NOTES:


- 1. NEW HANOVER COUNTY PARCEL NUMBERS.: PID = R06212-001-008-000 & R06212-001-002-000
- 2. TOTAL PROJECT AREA: 11.08 AC
- EXISTING ZONING DISTRICT: R-15
 THIS SITE IS LOCATED IN ZONE "X" ACCORDING TO THE FEDERAL EMERGENCY MANAGEMENT AGENCY'S FLOOD INSURANCE RATE MAP.
- COMMUNITY PANEL NUMBER 37203 15600J, DATED 4/3/06. 5. SITE ADDRESS: 6561 GREENVILLE LOOP ROAD
- 5. SITE ADDRESS: 6561 GREENVILLE LOOP ROAD
 6. BOUNDARY AND TOPOGRAPHIC SURVEY PERFORMED BY
- GEOINNOVATION, PC 6740 NETHERLANDS DR., UNIT A WILMINGTON, NC 28405
- 910–799–0099 7. VERTICAL DATUM: NAVD 88

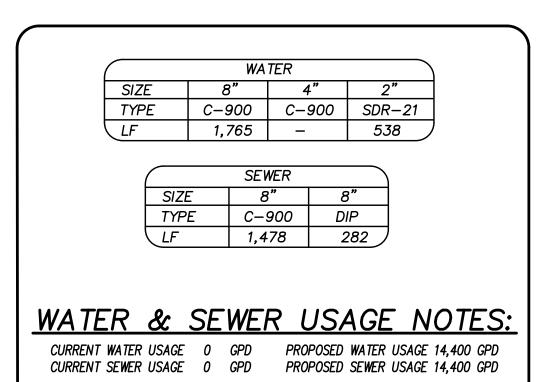


(40) 3 BEDROOM LOTS X 360 GPD = 14,400 GPD

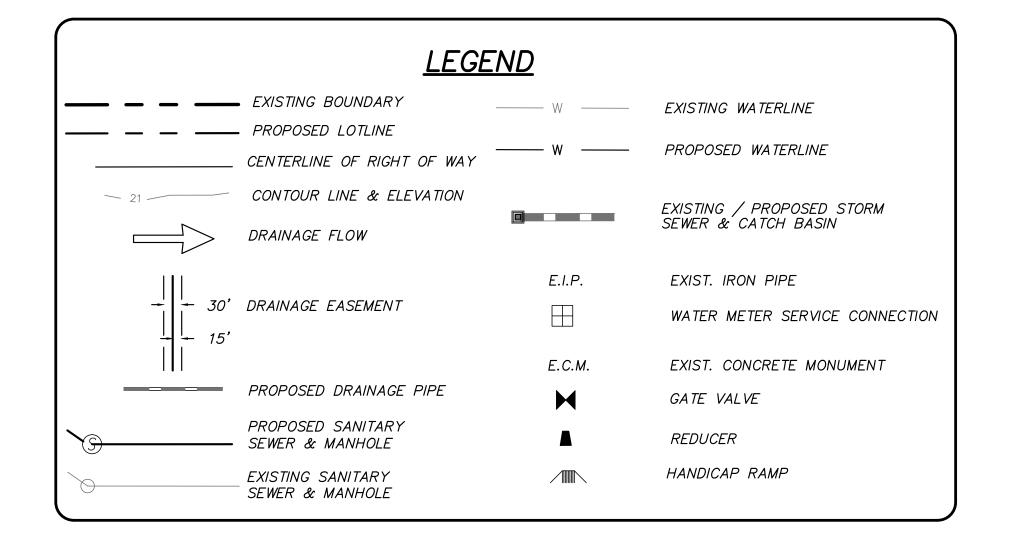

OWNER: ARYA HOLDINGS, LLC PO BOX 3122 WILMINGTON, NC 28406 910-538-7888

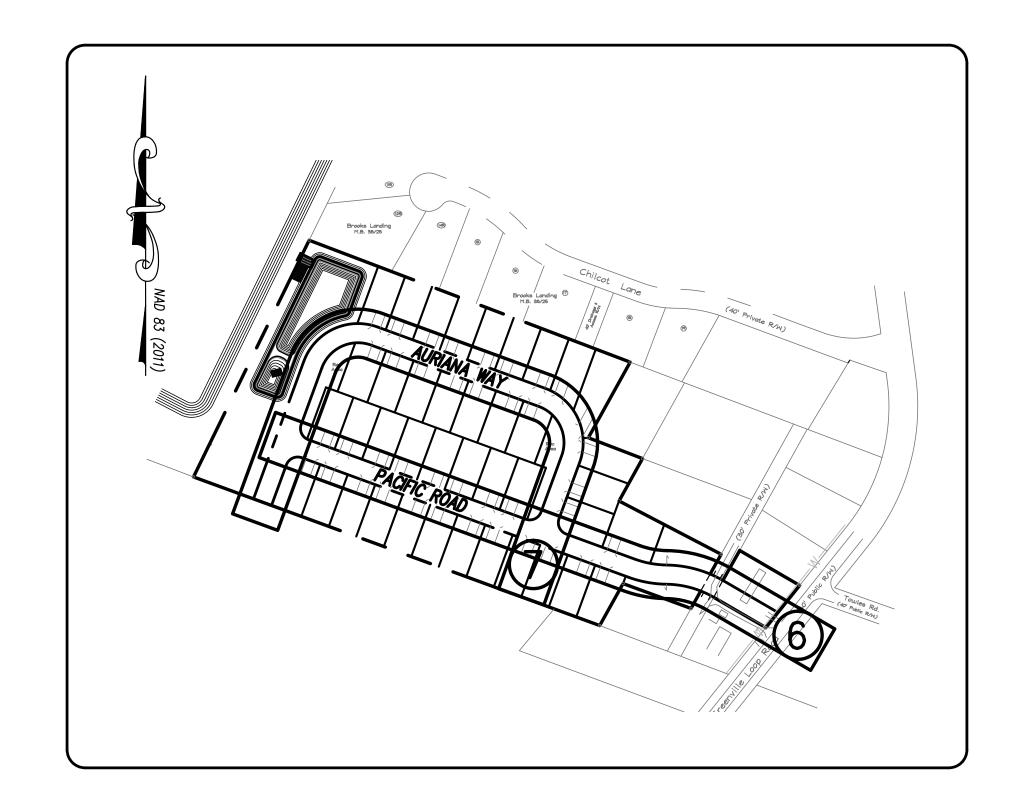

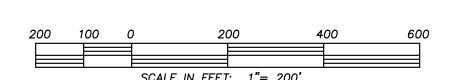

	INDEX TO DRAWINGS	
SHEET No.	DESCRIPTION	DRAWING No.
1 OF 15	COVER SHEET	CD_COV
2 OF 15	EXISTING BOUNDARY AND TOPOGRAPHY	EX_COND
3 OF 15	TREE INVENTORY	EX_COND
4 OF 15	TREE OVERLAY	TREE-OVERLAY
5 OF 15	SITE PLAN	SP_1
6 OF 15	PACIFIC ROAD	PP1
7 OF 15	AURIANA WAY	PP2
8 OF 15	LANDSCAPE PLAN	LP
9 OF 15	CITY OF WILMINGTON STANDARD DETAILS	DET_1
10 OF 15	CITY OF WILMINGTON STANDARD DETAILS	DET_2
11 OF 15	CFPUA STANDARD WATER DETAILS	WSD_1
12 OF 15	CFPUA STANDARD WATER DETAILS	WSD_2
13 OF 15	CFPUA STANDARD SEWER DETAILS	SSD_1
14 OF 15	CFPUA STANDARD SEWER DETAILS	SSD_2
15 OF 15	CFPUA STANDARD SEWER DETAILS	SSD_3

IOTES:

- 1. BOUNDARY AND TOPOGRAPHY SURVEY PERFORMED BY GEOINNOVATION, PC.
- 2. THIS MAP IS NOT FOR CONVEYANCE, RECORDATION, OR SALES.
- 3. THIS PROPERTY IS NOT LOCATED WITHIN A SPECIAL FLOOD HAZARD AREA ACCORDING TO FEMA MAPS.
- 4. THIS PROPERTY IS ZONED R-15
- 5. CFPUA WATER
- 6. CFPUA SEWER
- 7. ALL CONSTRUCTION TO CONFORM TO NEW HANOVER COUNTY STANDARDS AND APPLICABLE STATE & LOCAL CODES.
- 8. CONTRACTOR TO COORDINATE ANY REQUIRED TRAFFIC CONTROL WITH CITY OF WILMINGTON AND OR NCDOT.
- CITY OF WILMINGTON AND OR NCDOT.

 9. CARE SHALL BE TAKEN DURING FINAL GRADING TO ENSURE POSITIVE DRAINAGE AWAY FROM BUILDINGS AND TO RECEIVING STRUCTURES.

ROOF DRAIN DOWNSPOUTS TO BE CONNECTED TO STORM DRAINAGE

- STUBOUTS OR DIRECTED TO STREET/PARKING AREAS.

 10. CONTRACTOR IS RESPONSIBLE FOR COORDINATION OF ANY RELOCATIONS, RE—ALIGNMENTS, DISCONNECTIONS OR CONNECTIONS OF EXISTING UTILITIES WITH APPLICABLE AUTHORITIES.
- 11. CLEARING AND GRUBBING OF SITE TO INCLUDE REMOVAL OF EXISTING CURB, ASPHALT, INLETS, AND ANY OTHER STRUCTURES INCLUDING TREES, STUMPS AND DEBRIS EXISTING ON SITE. TREES NOT REQUIRED TO BE CLEARED FOR CONSTRUCTION SHALL REMAIN UNLESS OTHERWISE DIRECTED.
- 12. INFORMATION CONCERNING UNDERGROUND UTILITIES WAS OBTAINED FROM AVAILABLE RECORDS. IT SHALL BE THE RESPONSIBILITY OF THE CONTRACTOR TO DETERMINE THE EXACT ELEVATIONS AND LOCATIONS OF ALL EXISTING UTILITIES AT ALL CROSSINGS PRIOR TO COMMENCING TRENCH EXCAVATION. IF ACTUAL CLEARANCES ARE LESS THAN INDICATED ON PLAN, THE CONTRACTOR SHALL CONTACT THE DESIGN ENGINEER BEFORE PROCEEDING WITH CONSTRUCTION. ANY CONDITION DISCOVERED OR EXISTING THAT WOULD NECESSITATE A MODIFICATION OF THESE PLANS SHALL BE BROUGHT TO THE ATTENTION OF THE DESIGN ENGINEER BEFORE PROCEEDING WITH CONSTRUCTION.
- 13. NO CONSTRUCTION IS TO BEGIN BEFORE LOCATION OF EXISTING
 UTILITIES HAS BEEN DETERMINED. CALL "NC ONE—CALL" AT LEAST
 48 HOURS BEFORE COMMENCING CONSTRUCTION.
- 14. CONTRACTOR SHALL ADJUST ALL MANHOLES, VALVE & CURB BOXES TO FINAL GRADE UPON COMPLETION OF ALL CONSTRUCTION. ANY BOXES DAMAGED OR OTHERWISE DISTURBED BY THE CONTRACTOR SHALL BE REPAIRED AT THE EXPENSE OF THE CONTRACTOR.
- 15. THE CONTRACTOR IS RESPONSIBLE FOR CONTROLLING DUST AND EROSION DURING CONSTRUCTION AT HIS EXPENSE. PARKING AREAS SHALL BE WATERED TO CONTROL DUST WHEN ORDERED BY THE ENGINEER.
- 16. NO GEOTECHNICAL TESTING HAS BEEN PERFORMED ON SITE. NO WARRANTY IS MADE FOR SUITABILITY OF SUBGRADE, AND UNDERCUT AND ANY REQUIRED REPLACEMENT WITH SUITABLE MATERIAL SHALL BE THE RESPONSIBILITY OF THE CONTRACTOR.
- 17. CONTRACTOR TO ENSURE THAT PAVEMENT IS PLACED SO AS TO DRAIN POSITIVELY TO THE STREET INLETS AND CATCH BASINS. ALL FUTURE ROOF DRAIN DOWNSPOUTS TO BE DIRECTED TO THE STORM DRAINAGE STUBOUTS.
- 18. CONTRACTOR IS RESPONSIBLE FOR OBTAINING ALL REQUIRED PERMITS.

 19. THIS PLAN IS FOR SITE GRADING, UTILITIES, SITING, AND DRAINAGE ONLY.

 SEE BUILDING PLANS FOR DETAILED HOOKUPS TO BUILDINGS, ETC.
- 20. CONTRACTOR AND BUILDER ARE RESPONSIBLE FOR COORDINATING
 FINISHED FLOOR ELEVATION OF ALL BUILDINGS WITH THE OWNER. ELEVATIONS
 GIVEN ARE MINIMUM GROUND ELEVATIONS AT THE BUILDING SITE AND DO NOT
 PURPORT TO BE FINISHED FLOOR. MINIMUM RECOMMENDED FF ELEVATIONS
 SHOWN ON PLANS.
- 21. AFFECTED NON—MUNICIPAL UTILITIES SHALL BE CONTACTED AND PROVIDED WITH PLANS AND OTHER PERTINENT INFORMATION, WHEN FEASIBLE, TO COORDINATE APPROPRIATE SCHEDULING AND PLACEMENT.
- 22. EXTREME CARE SHALL BE TAKEN TO ENSURE MINIMUM SEPARATIONS AT ALL UTILITY CROSSINGS.
- 23. MINIMUM SEPARATION SHALL BE MAINTAINED AS FOLLOWS:
 a. HORIZONTAL SEPARATION OF 10 FEET BETWEEN SANITARY SEWER AND
 WATER MAINS AND STORM SEWER.
 - b. WHERE VERTICAL CLEARANCE IS LESS THAN 24" BETWEEN SANITARY
 SEWER AND WATER OR WHERE SEWER LINE CROSSES ABOVE WATER
 MAIN, BOTH PIPES SHALL BE DUCTILE IRON PIPE FOR A MINIMUM
 OF 10' EITHER SIDE OF CROSSING.
 - c. WHERE VERTICAL CLEARANCE IS LESS THAN 24" BETWEEN SANITARY SEWER AND STORM DRAIN, SANITARY SEWER SHALL BE DUCTILE IRON PIPE FOR A MINIMUM OF 10 FEET EITHER SIDE OF CROSSING.
 - d. WHERE VERTICAL CLEARANCE IS LESS THAN 12" BETWEEN SANITARY
 SEWER AND STORM DRAIN, SANITARY SEWER SHALL BE DUCTILE IRON
 PIPE FOR A MINIMUM OF 10' EITHER SIDE OF CROSSING, AND BRIDGING
 SHALL BE INSTALLED PER APPLICABLE UTILITY AUTHORITY'S DETAILS.
 e. IN NO CASE SHALL THERE BE LESS THAN 18" OF SEPARATION BETWEEN
 - OUTSIDE OF WATER MAIN AND OUTSIDE OF SEWER OR STORM DRAINAGE. f. MINIMUM COVER OF 36" SHALL BE PROVIDED FOR ALL BURIED WATER
- MAINS AND SANITARY SEWER MAINS.

 24. SEE DETAIL SHEETS FOR TYPICAL UTILITIES HOOKUPS.
- 25. ALL SANITARY SEWER MAINS TO BE 8" UNLESS OTHERWISE INDICATED.
- 26. ALL WATER MAINS TO BE 8" UNLESS OTHERWISE INDICATED.
- 27. TWO VALVES ARE REQUIRED AT "T" INTERSECTIONS AND ONE VALVE ON THE WATER LINE TO FIRE HYDRANTS.
- 28. A BLOW-OFF VALVE IS REQUIRED AT THE TERMINUS OF ALL "DEAD END" WATER LINES.

(S) CSD ENGINEERING

> LICENSE # C-2710 ENGINEERING LAND PLANNING COMMERCIAL / RESIDENTIAL

P.O. BOX 4041 WILMINGTON, NC 28406 (910) 791–4441

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ACIFIC PLACE


CATED IN CITY OF WILMINGTON

EW HANOVER COUNTY, NORTH CAROLINA

WNER: ARYA HOLDINGS, LLC

PO BOX 3122

WILMINGTON, NC 28406

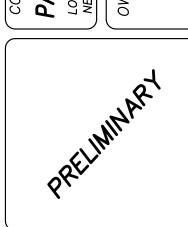

			9/08		
			NSn	ВУ	
			REVISED INDEX TO DRAWINGS TO INCLUDE LANDSCAPE PLAN	REMARKS	
			1	REV. NO.	

DATE: 7-12-17


HORZ. SCALE: 1" = 200'
VERT. SCALE: N/A

DRAWN BY: MRB

CHECKED BY: HSR

PROJECT NO.: 17-0398

Sheet No. _____ Of _____

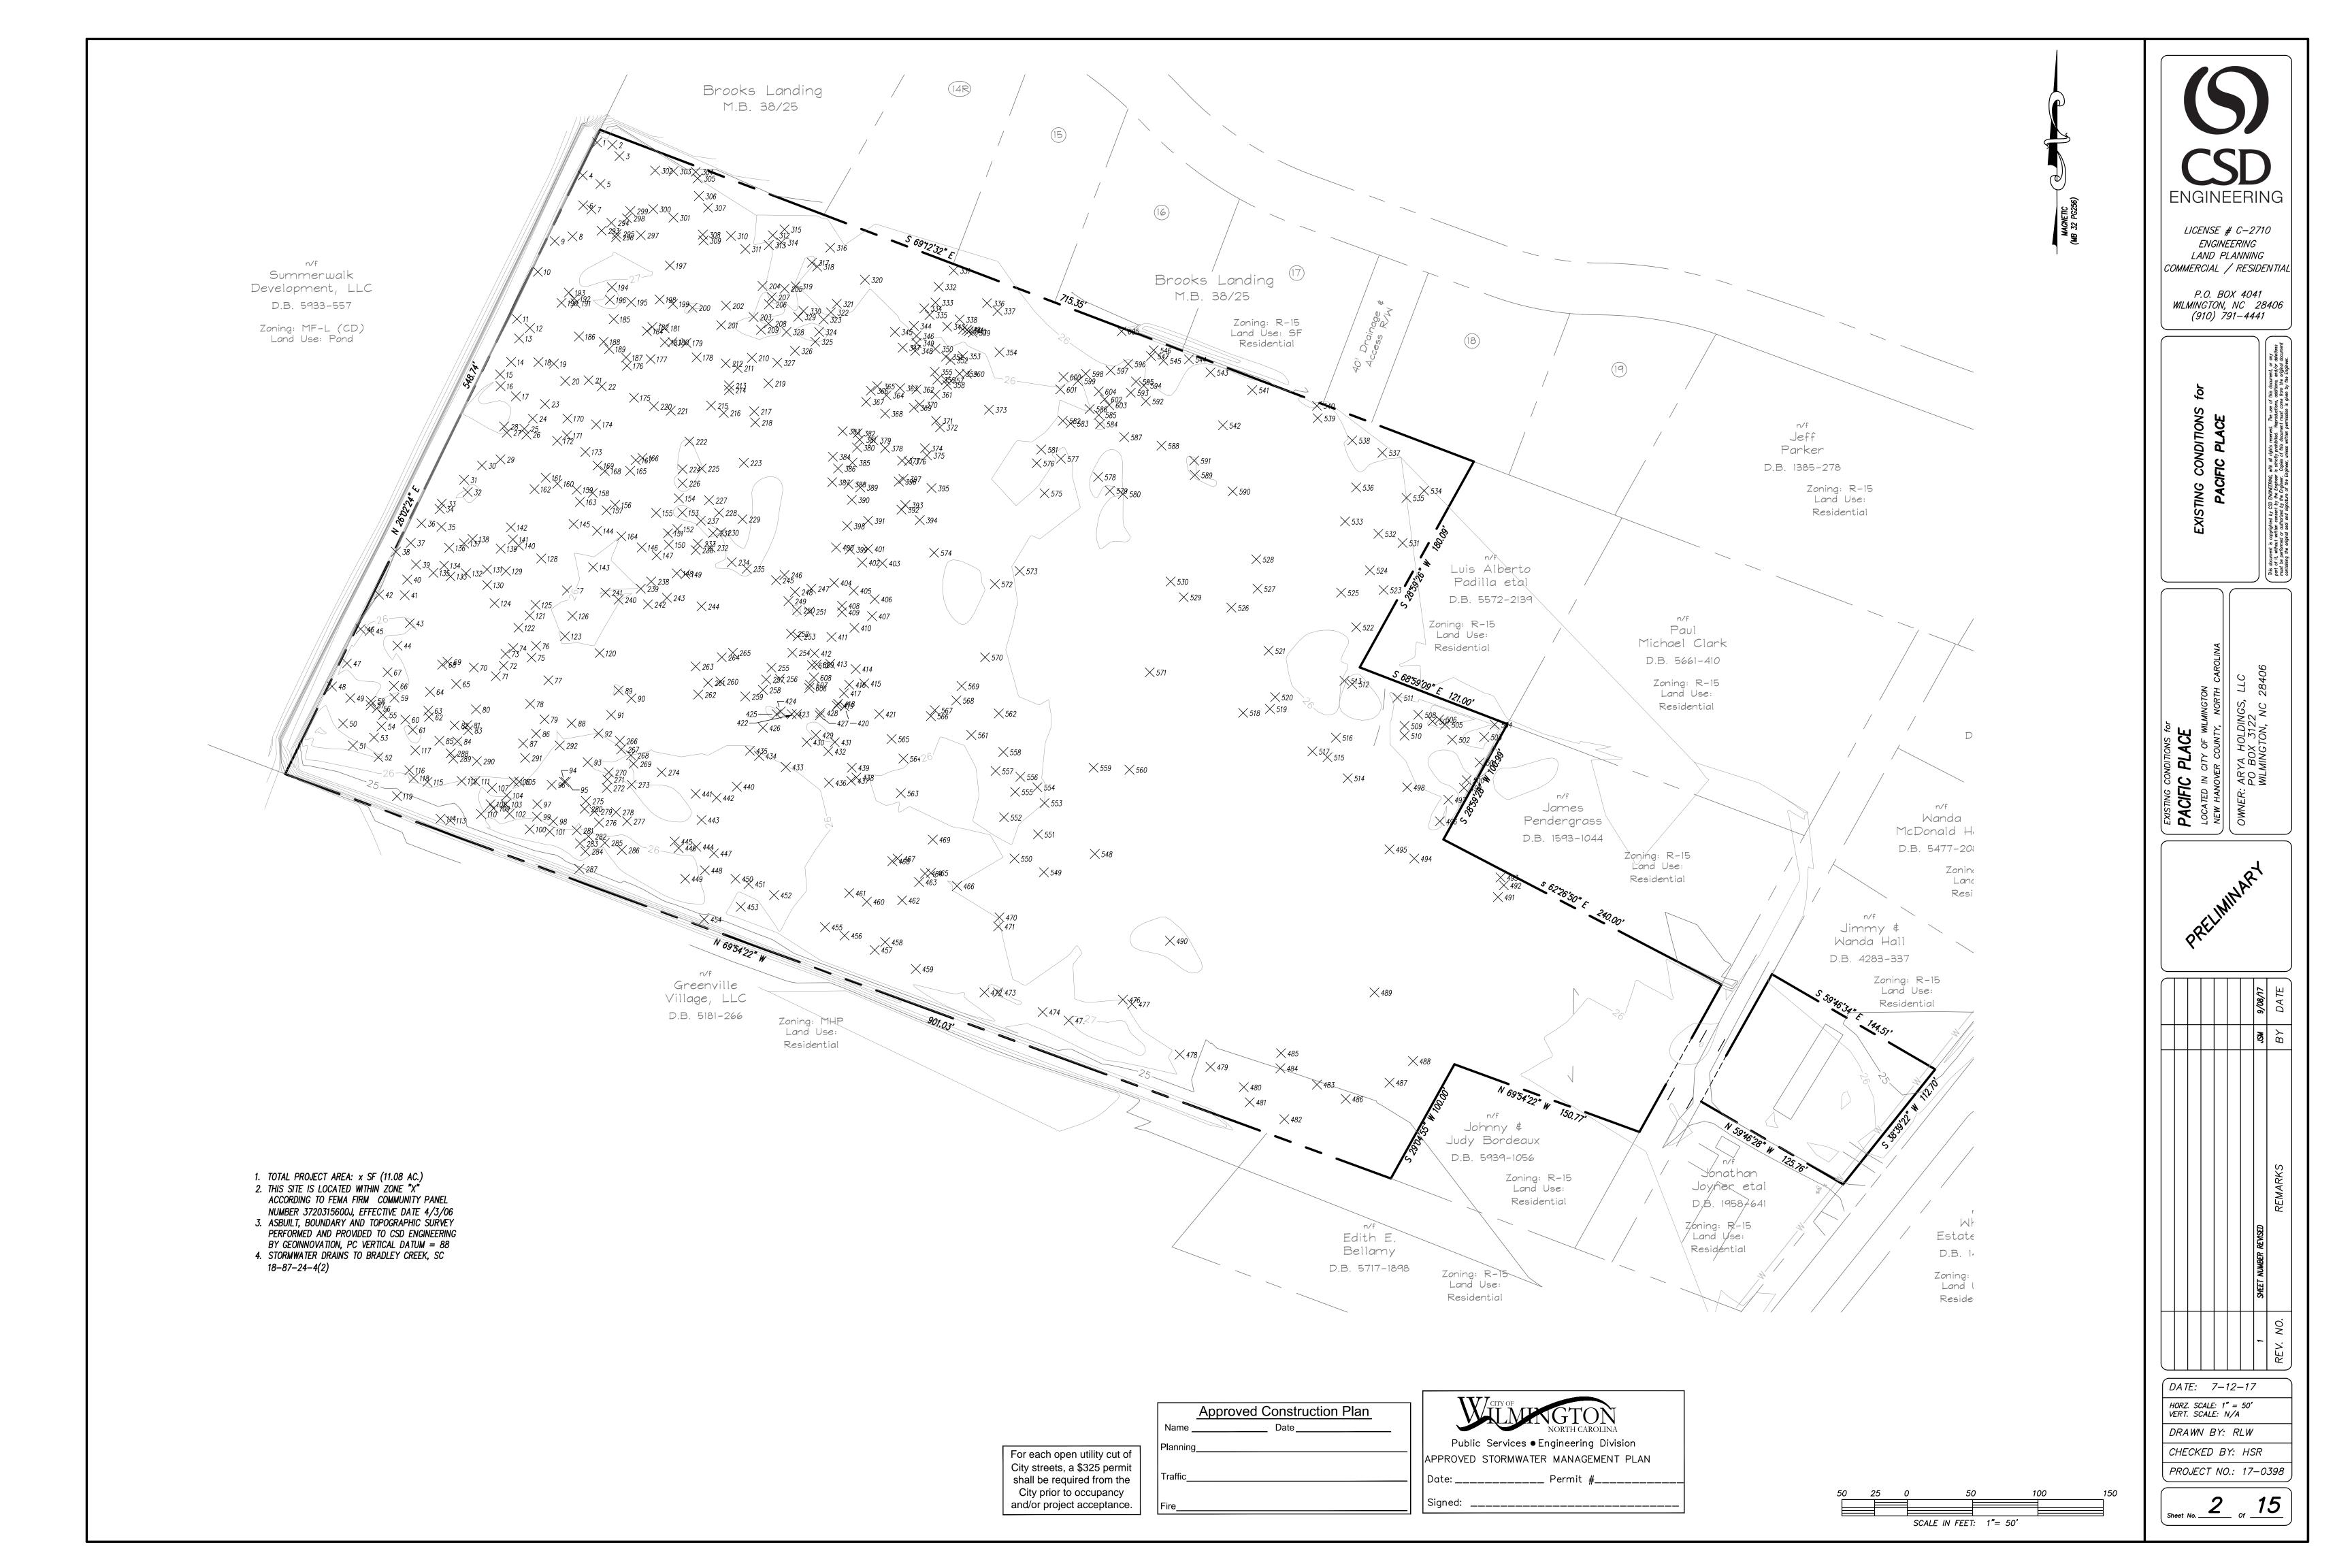

 Р	Point Table		Point Table		Point Table		Point Table		oint Table
oint #	Raw Description	Point #	Raw Description						
	12P	66	12P	131	12P	196	13P	261	12P
2	12P	67	12P	132	13P	197	13P	262	12P
3	16P	68	11 MAG	133	15P	198	6 MAG	263	12P
4	12P	69	8 MAG	134	12P	199	12P	264	13P
5	17P	70	12 MAG	135	12P	200	12P	265	13P
6	14P	71	9 BAY	136	6 MAG	201	12P	266	18P
7	2-6BAYS	72	12P	137	17P	202	12P	267	12P
8	12P	73	12P	138	12P	203	12P	268	12P
9	12P	74	12P	139	13P	204	12P	269	12P
10	16P	75	12P	140	7 OAK	205	12P	270	12P
11	12P	76	12P	141	12P	206	12P	271	16P
12	12P	77	12P	142	14P	207	13P	272	6 MAG
13	12P	78	12P	143	16P	208	12P	273	12P
14	16P	79	12P	144	12P	209	15P	274	13P
15	2-6 BAYS	80	14P	145	12P	210	12P	275	13P
16	14P	81	12P	146	12P	211	12P	276	
17	12P	82	7 BAY	147	12P	212	12P	277	
18	13P	83	6 BAY	148	12P	213	14P	278	12P
19	12P	84	8 BAY	149	12P	214	7 BAY	279	14P
20	12P	85	6 BAY	150	16P	215	2 - 7 BAY	280	14P
21	12P	86	12P	151	13P	216	8 BAY	281	13P
22	13P	87	12P	152	12P	217	8 BAY	282	16P
23	12P	88	12P	153	12P	218	2 - 6 BAY	283	18P
24	12P	89	12P	154	13P	219	2 - 7 BAY	284	16P
25	18P	90	14P	155	13P	220	11 MAG	285	12P
26	16P	91	14P	156	12P	221	12P	286	15P
27	14P	92	13P	157	12P	222	12P	287	7 GUM
28	16P	93	12P	158	12P	223	12P	288	12P
29	15P	94	13P	159	12P	224	14P	289	15P
30	13P	95	13P	160	12P	225	8 OAK	290	12P
31	7 MAG	96	12P	161	12P	226	4 - 6 BAY	291	13P
32	13P	97	12P	162	14P	227	22P	292	13P
33	12P\	98	22P	163	14P	228	12P	293	12P
34	13P	99	14P	164	14P	229	20P	294	13P
35	6 MAG	100	12P	165	14P	230	12P	295	13P
36	12P	101	14 GUM	166	12P	231	12P	296	13P
 37	12P	102	15P	167	12P	232	12P	297	17P.
38	12P	103	14P	168	12P	233	12P	298	13P
39	13P	104	12P	169	12P	234	12P	299	14P
40	17P	105	13P	170	12P	235	12P	300	12P
41	12P	106	12P	171	12P	236	10 OAK	301	12P
42	7 MAG	107	15P	172	13P	237	8 OAK	302	12P
43	16P	108	12P	173	13P	238	16P	303	10 GUM
44	14P	109	14P	174	17P	239	15P	304	8 GUM
45	16P	110	12P	175	15P	240	13P	305	12P
46	12P	111	12P	176	12P	241	5 MAG	306	15P
47	13P	112	18P	177	12P	242	12P	307	17P
48	13P	113	11 GUM	178	12P	243	12P	308	13P
49	17P	114	12P	179	12P	244	13P	309	12P
50	16P	115	15P	180	13P	245	12P	310	12P
51	16P	116	12P	181	13P	246	8 OAK	311	12P
52	12P	117	13P\	182	13P	247	2-6 BAY	312	22P
53	12P	118	13P	183	12P	248	12P	313	12P
54	12P	119	13P	184	12P	249	12P	314	12P
55	12P	120	13P	185	12P	250	12P	315	8 OAK
 56	12P	121	13P	186	12P	251	12P	316	8 OAK
57	12P	122	13P	187	2- 6 MAG	252	12P	317	9 GUM
 58	12P	123	16P	188	6 MAG	253	3 - 7 BAY	318	9 GUM
 59	12P	124	7 MAG	189	14P	254	8 BAY	319	11 BAY
 60	13P	125	12P	190	12P	255	18P	320	13P
61	12P	125	18P	191	13P	256	4 - 7 BAY	321	7 BAY
62	14P	126	15P	192	13P	257	2 - 7 BAY	322	12P
63	14P 12P		15P 14P	193	13P	258	13P	323	12P
		128	14P	194	13P	259	14P	324	13P
64	12P	129		195	13P	260	14P	325	12P
65	18P	130	13P		1 01		1 11		

Р	oint Table	Р	oint Table	Р	oint Table	Р	oint Table
Point #	Raw Description	Point #	Raw Description	Point #	Raw Description	Point #	Raw Descript
326	12P	391	12P	456	15P	521	12P
327	12P	392	12P	457	17P	522	12P
328	15P	393	12P	458	15P	523	16P
329	12P	394	12P	459	15P	524	8 BAY
330	12P	395	12P	460	17P	525	8 BAY
331	14 OAK	396	12P	461	6 BAY	526	16P
332	14P	397	5 MAG	462	14P	527	12P
333	10 GUM	398	2 - 9 BAY	463	13P	528	12P
334	14P	399	2 - 7 BAY	464	6 BAY	529	12P
335	14P	400	12P	465	12P	530	2 - 12P
336	20P	401	12P	466	12P	531	12P
337	14P	402	14P	467	12P	532	12P
338	7 MAG	403	18P	468	6 BAY	533	12P
339	12P	404	13P	469	12P	534	26P
340	12P	405	12P	470	9 MAG	535	22P
341	20P	406	12P	471	11 MAG	536	12P
342	15P	407	12P	472	12P	537	16P
343	24P	408	12P	473	14P	538	14P
344	10 GUM	409	7 BAY	474	14P	539	16P
345	8 BAY	410	13P	475	14P	540	20P
346	8 BAY	411	13P	476	12P	541	16P
347	12P	412	14P	477	8 MAG	542	16P
348	12P	413	12P	478	2 - 12P	543	12P
349	12P	414	12P	479	12P	544	16P
350	16P	415	12P	480	12P	545	16P
351	3 - 7 BAY	416	8 BAY	481	12P	546	13P
352	12P	417	8 BAY	482	14P	547	9 OAK
353	7 BAY	418	10 BAY	483	14P	548	12P
354	13P	419	10 BAY	484	12P	549	12P
355	12P	420	6 BAY	485	12P	550	16P
356	7 BAY	421	6 MAG	486	12P	551	3 - 8 BA
357	8 BAY	422	2 - 8 BAY	487	12P	552	7 BAY
358	12P	423	2 - 8 BAY	488	18P	553	18P
359	13P	424	8 BAY	489	14P	554	12P
360	3 -6 BAY	425	2 - 8 BAY	490	12P	555	16P
361	12P	426	16P	491	10 GUM	556	13P
362	2 — 12P	427	12P	492	10 OAK	557	13P
363	16P	428	14P	493	9 GUM	558	13P
364	12P	429	12P	494	16P	559	12P
365	7 BAY	430	12P	495	14P	560	16P
366	12P	431	12P	496	13P	561	6 BAY
367	12P	432	16P	497	7 GUM	562	10 BAY
368	12P	433	12P	498	12P	563	13P
369	12P	434	22P	499	14P	564	12P
370	10 BAY	435	8 OAK	500	13 GUM	565	8 BAY
371	12P	436	6 BAY	501	12P	566	12P
372	12P	437	6 BAY	502	12P	567	12P
373	12P	438	6 BAY	503	12P	568	6 BAY
374	12P	439	8 BAY	504	20 OAK	569	6 BAY
375	7 BAY	440	8 OAK	505	12P	570	9 BAY
376	12P	441	16P	506	12P	571	12P
377	18P	442	22P	507	14P	572	12P
378	12P	443	12P	508	13P	573	13P
379	2 - 10 BAY	444	12P	509	12P	574	12P
380	8 BAY	445	12P	510	12P	575	7 BAY
381	2 - 5 BAY	446	12P	511	14P	576	12P
382	12P	447	16P	512	17P	577	12P
383	12P	448	13P	513	12P	578	12P
384	12P	449	18P	514	16P	579	14P
385	12P	450	16P	515	12P	580	14P
386	6 MAG	451	12P	516	12P	581	7 BAY
387	2 -5 BAY	452	12P	517	12 OAK.	582	12P
388	12P	453	18P	518	12P	583	2 - 7 BA
389	12P	454	12P	519	12P	584	12P
	1	1		1		585	

P	oint Table
Point #	Raw Description
586	13P
587	12P
588	12P
589	12P
590	12P
591	2 - 12P
592	12P
593	12P
594	12P
595	12P
596	12P
597	12P
598	15P
599	12P
600	12P
601	8 OAK
602	8 OAK
603	15P
604	14P
605	18P
606	12P
607	12P
608	7 BAY
609	2 - 7 BAY
610	12P

	Approved Construction Plan
Name _	Date
Planning	I
Traffic_	

	WILMIGTON NORTH CAROLINA
-	Public Services • Engineering Division APPROVED STORMWATER MANAGEMENT PLAN
-	Date: Permit #
	Signed:

For each open utility cut of City streets, a \$325 permit shall be required from the City prior to occupancy and/or project acceptance.

S
CSD
ENGINEERING

LICENSE # C-2710

ENGINEERING

LAND PLANNING

COMMERCIAL / RESIDENTIAL

P.O. BOX 4041 WILMINGTON, NC 28406 (910) 791—4441

FACIFIC FLACE

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NER: ARYA HOLDINGS, LLC
PO BOX 3122
WII MINGTON NC 28406

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					NSN	ВҮ	
					SHEET NUMBER REVISED	REMARKS	
					1	REV. NO.	
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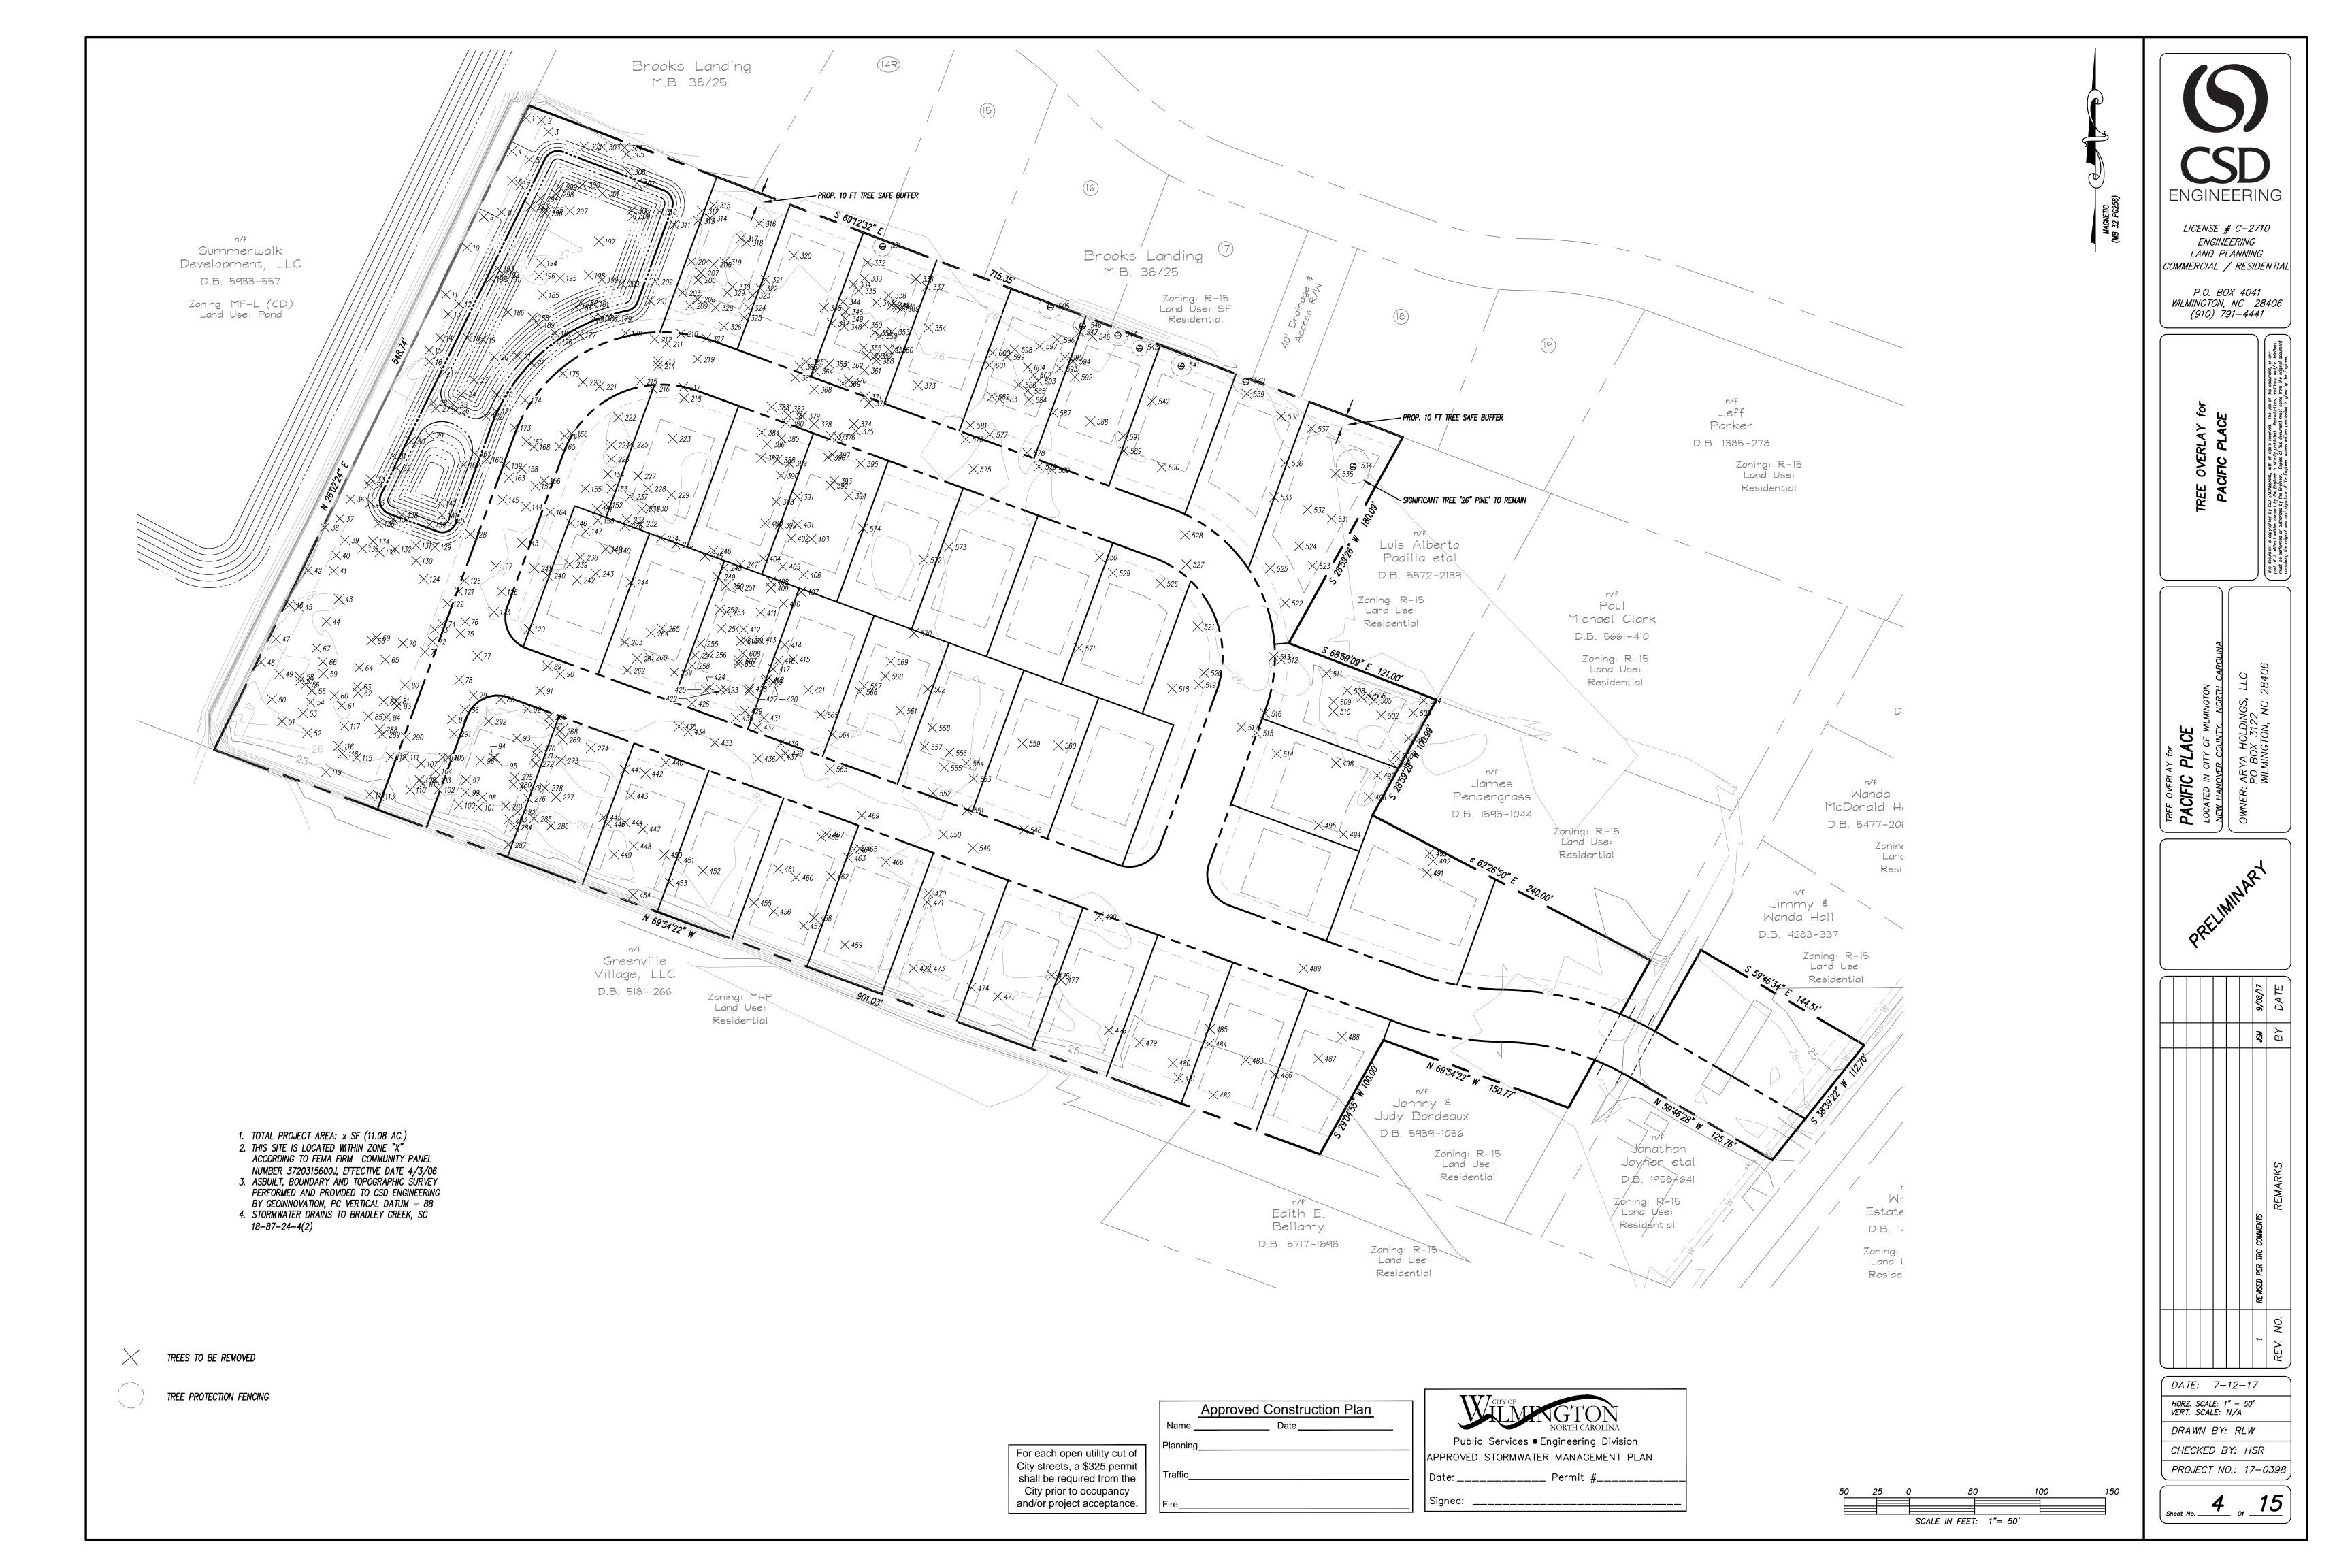
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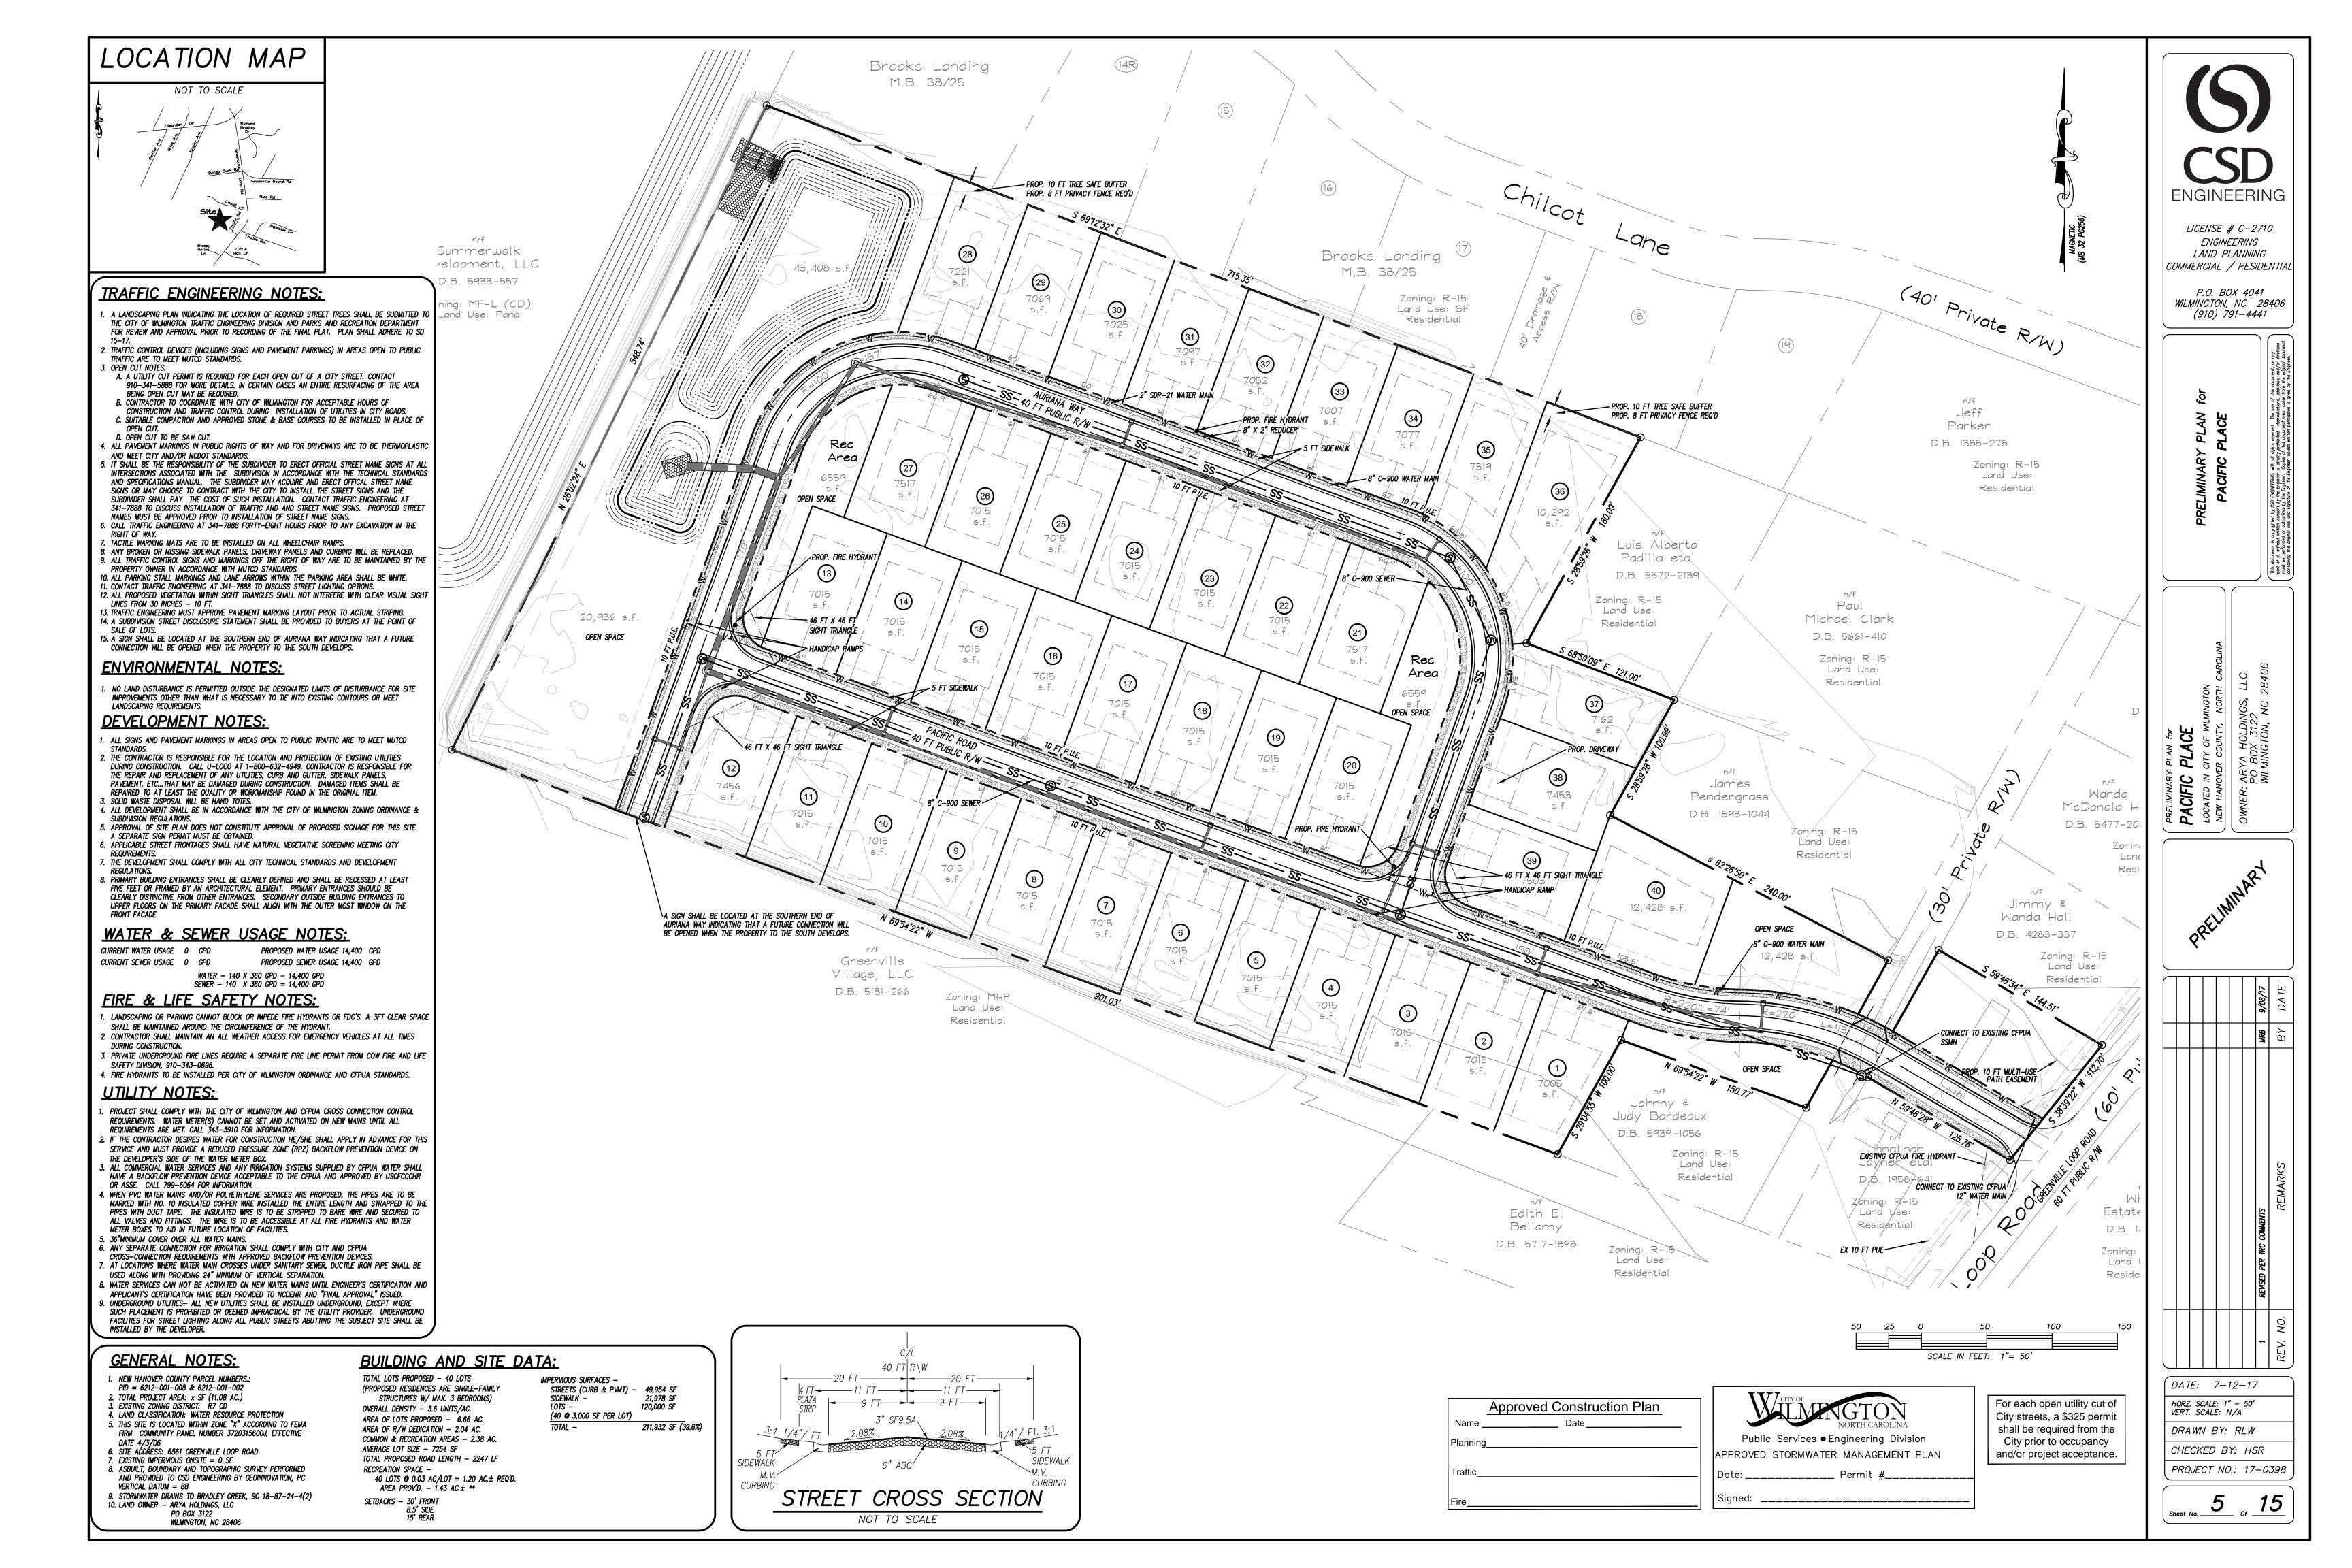
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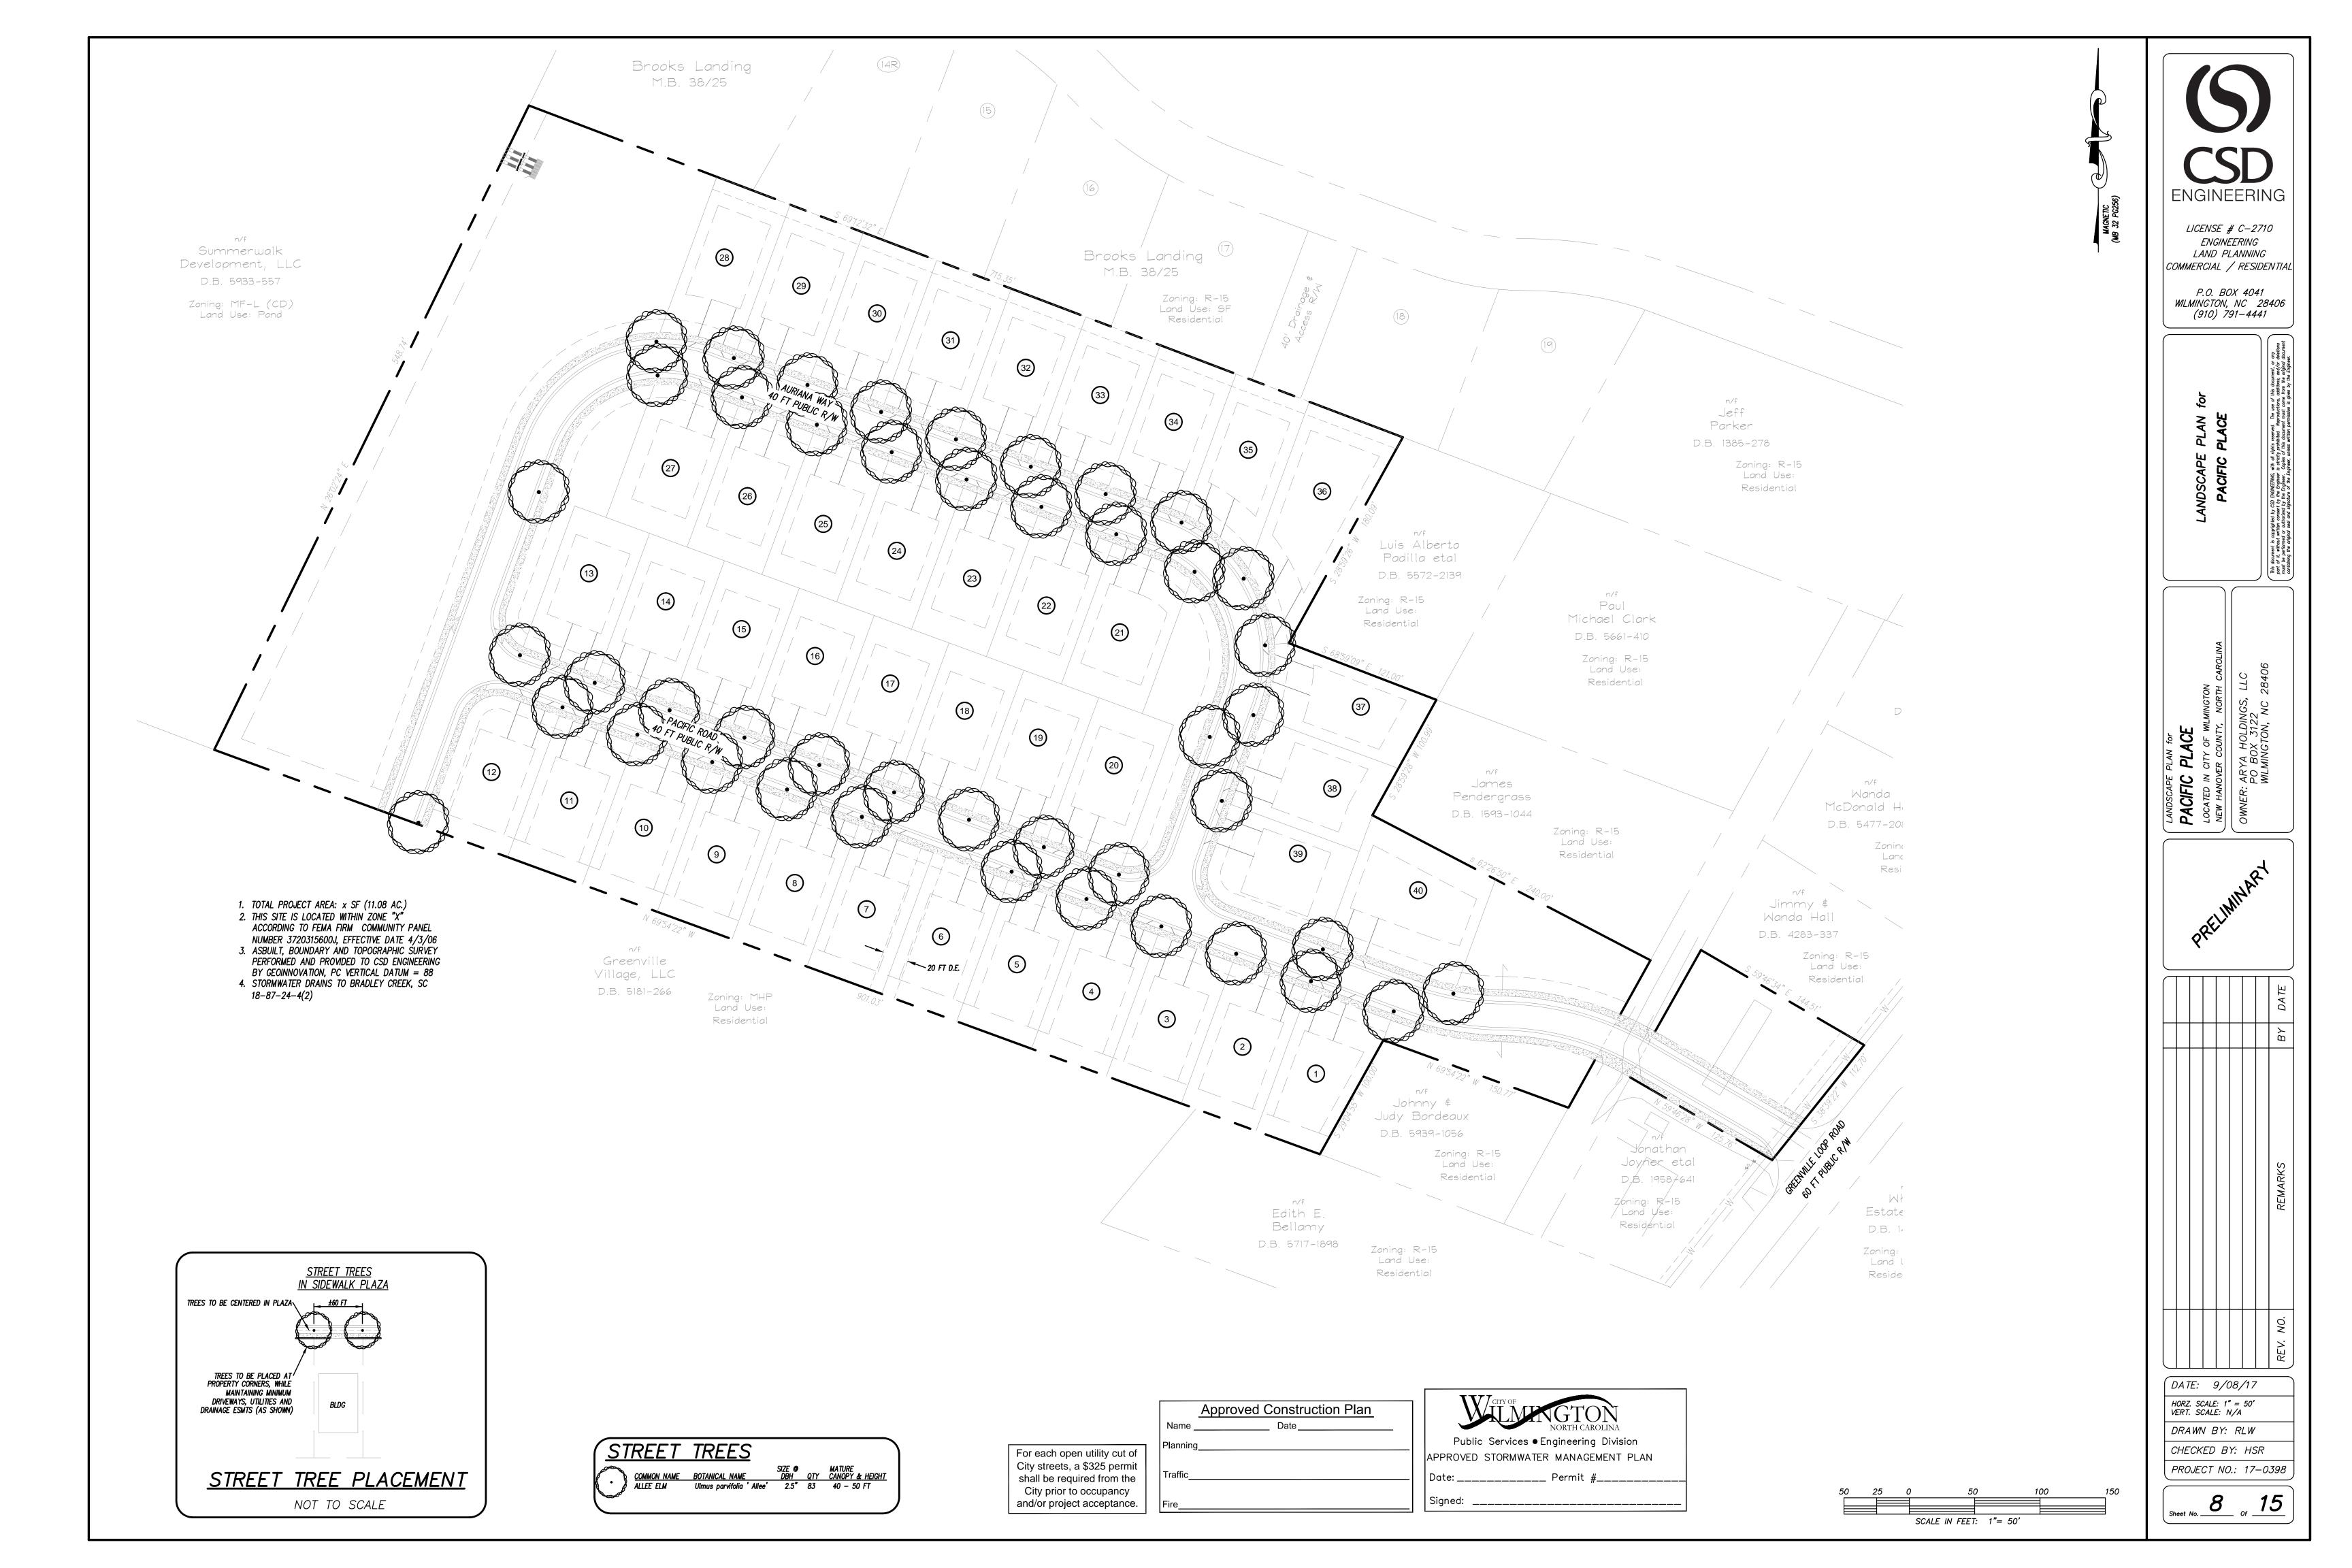
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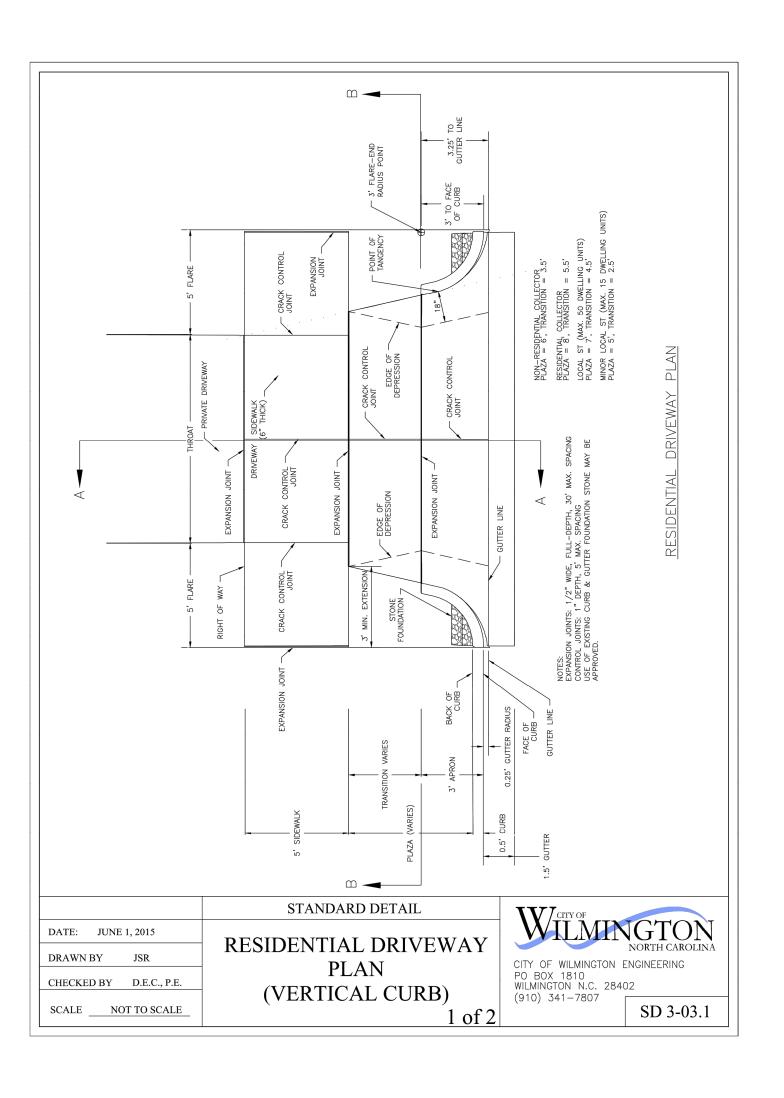
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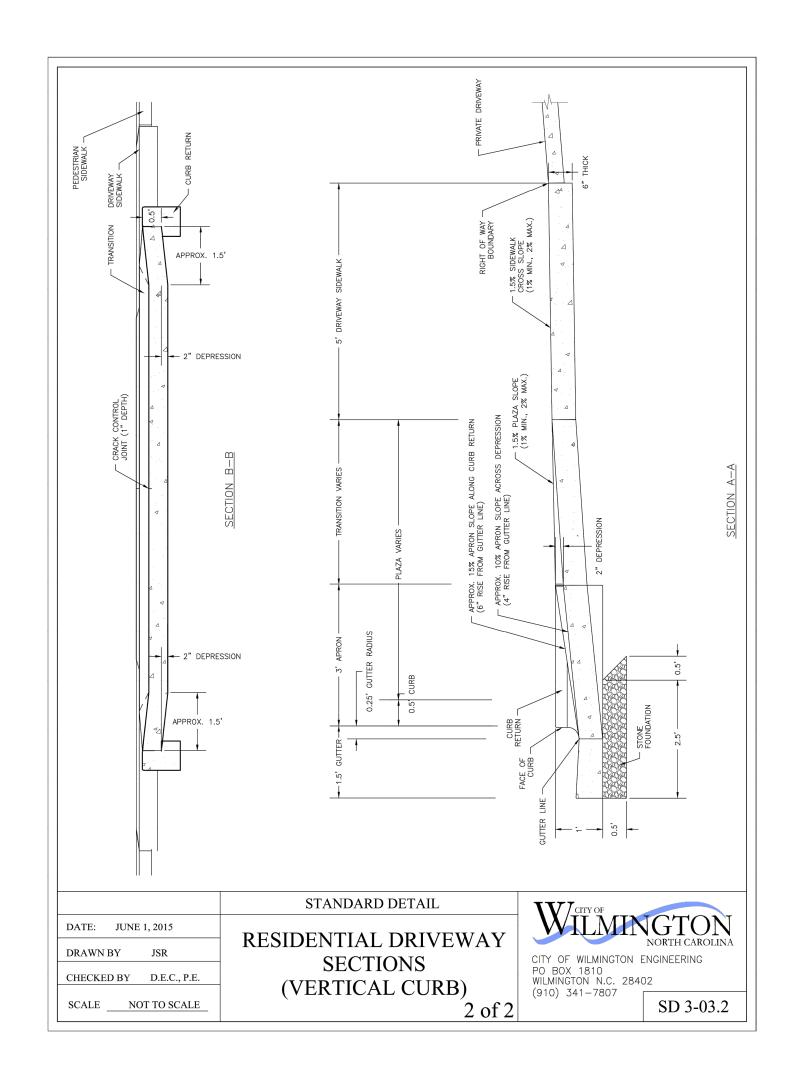
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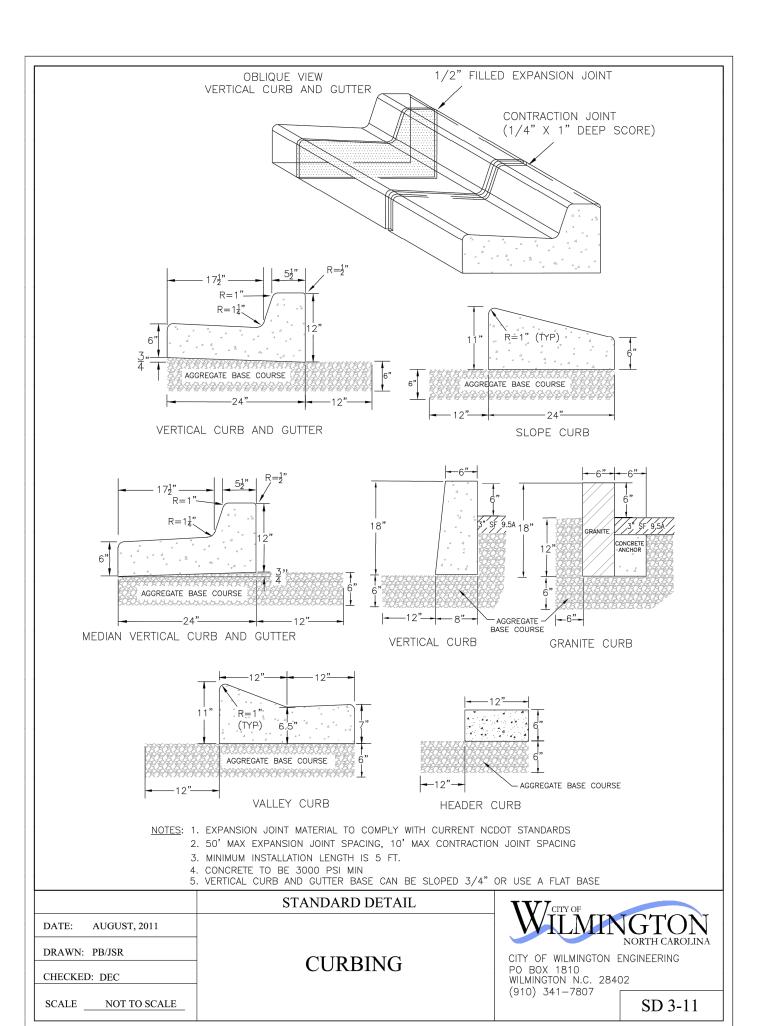















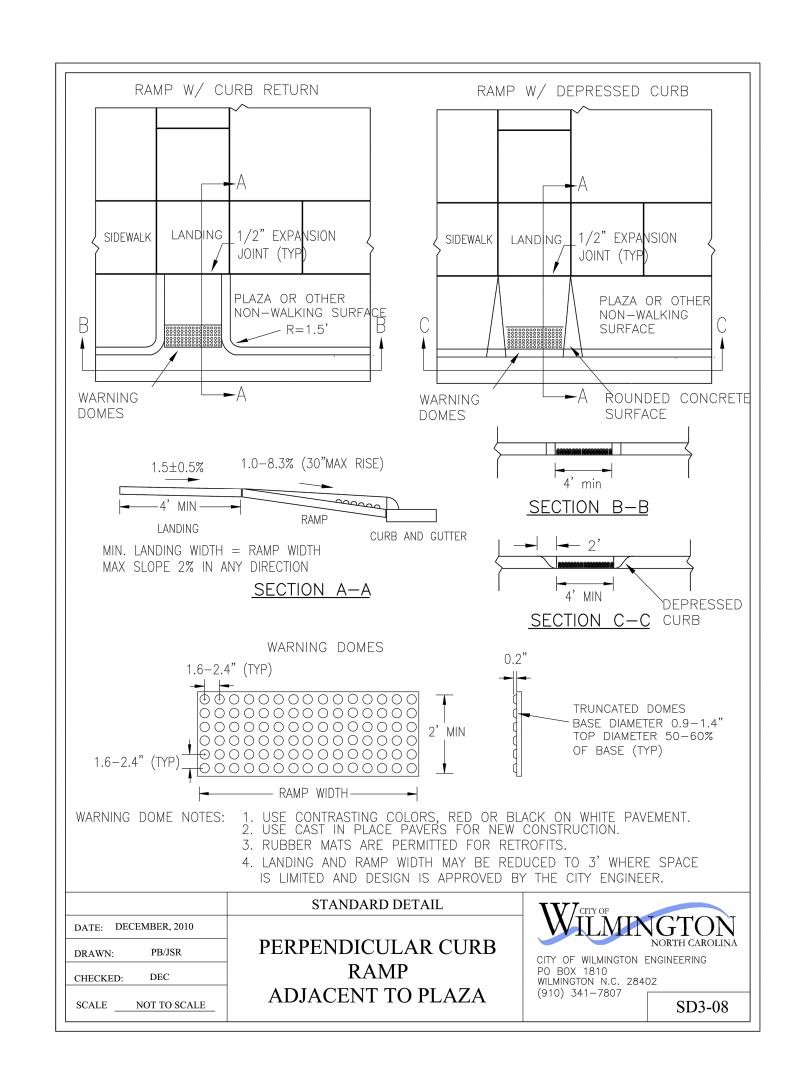

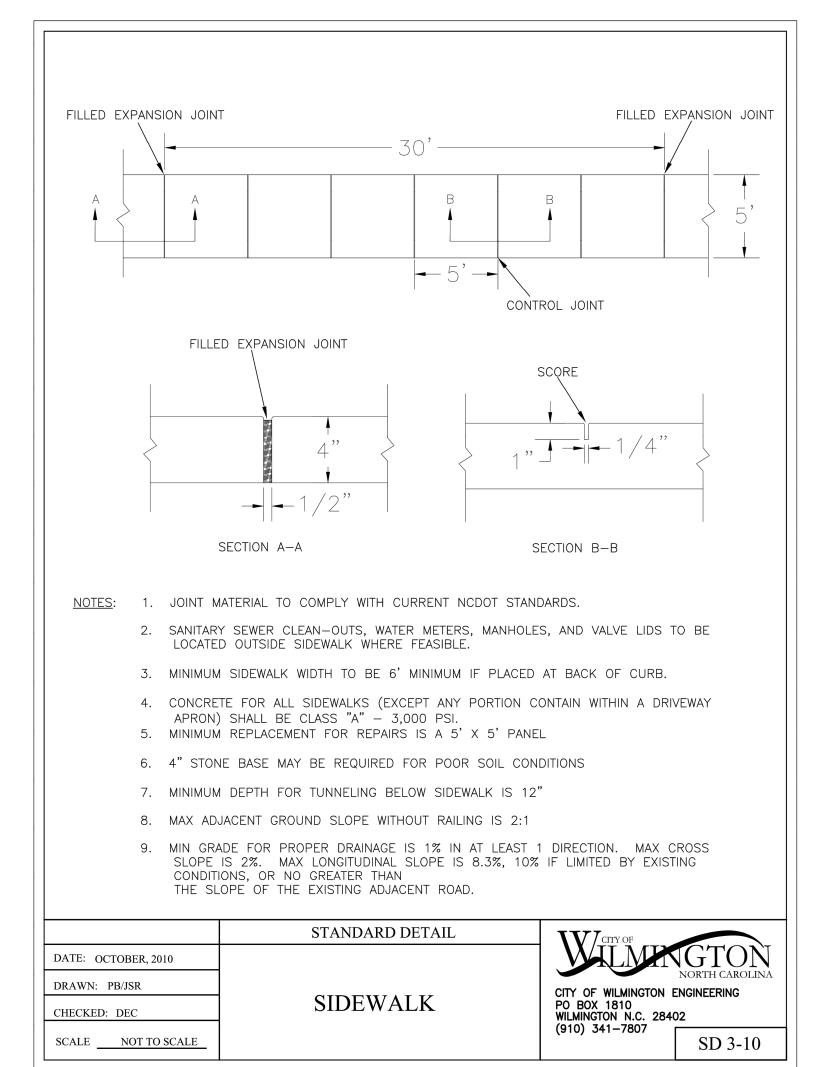

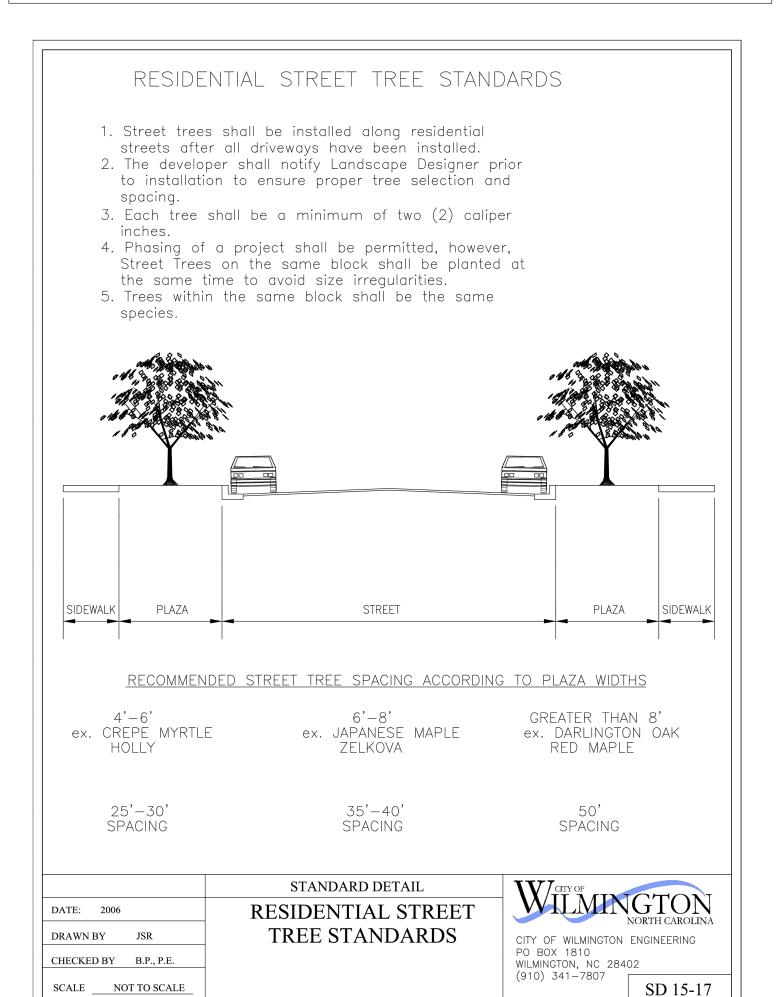




LAND PLANNING COMMERCIAL / RESIDENTIAL

P.O. BOX 4041 WILMINGTON, NC 28406 (910) 791–4441




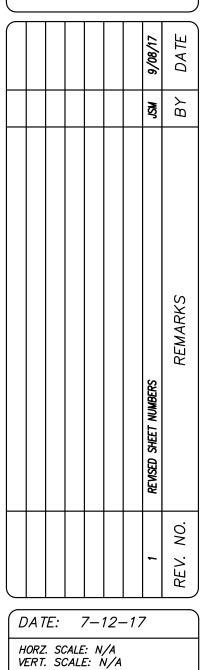

PROJECT NO.: 17-0398


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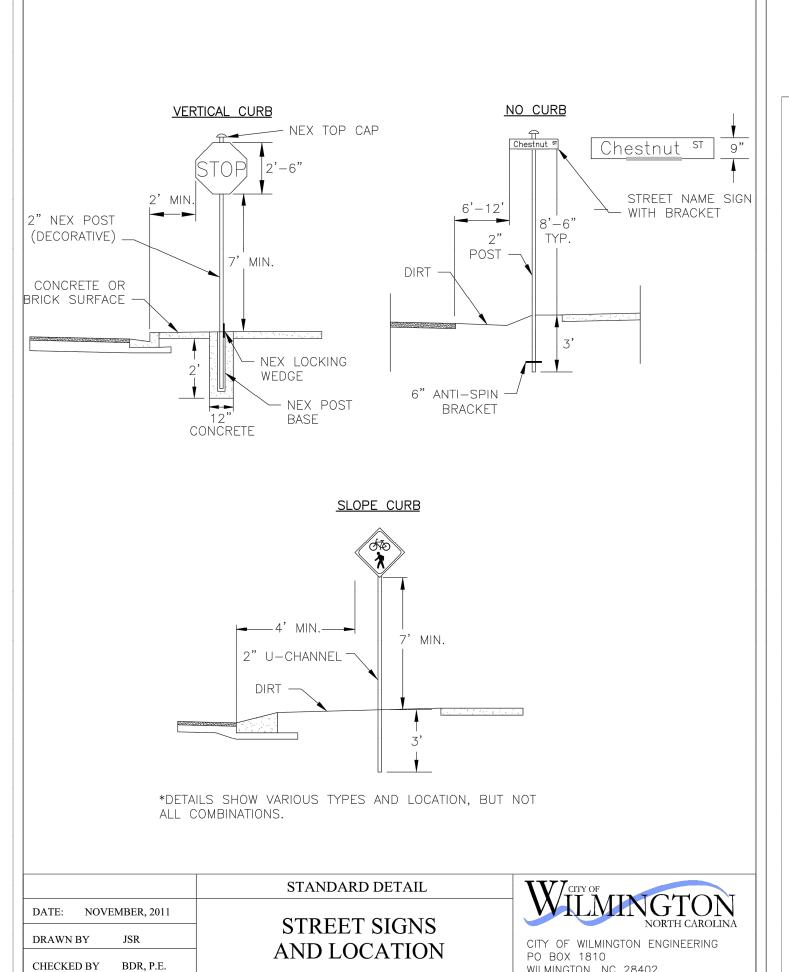
CHECKED BY: HSR

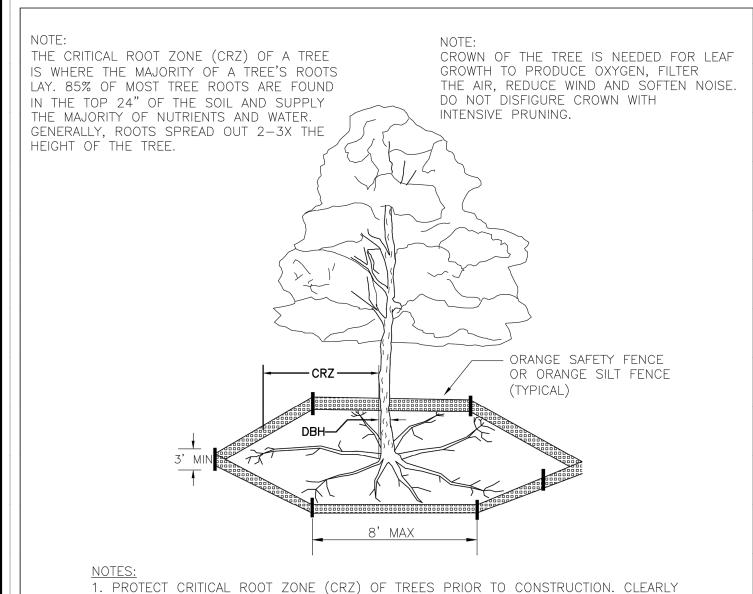


- 1. PROTECT CRITICAL ROOT ZONE (CRZ) OF TREES PRIOR TO CONSTRUCTION. CLEARLY MARK THE TREES AND ERECT A PROTECTIVE BARRIER AT THE CRZ. BARRIER SHALL BE MAINTAINED UNTIL CONSTRUCTION IS COMPLETE.
- 2. CRZ RADIUS IS 1 FT PER INCH OF TREE DIAMETER AT BREAST HEIGHT (DBH). 3. IF CONSTRUCTION OCCURS WITHIN THE CRZ, AT LEAST 12" OF MULCH AND/OR LOGGING MATTS SHALL BE PLACED WHERE MACHINERY MANEUVERS TO REDUCE SOIL
- 4. WHERE SIDEWALKS AND PATHWAYS PASS WITHIN CRZ, EXTRA CARE SHALL BE TAKEN TO AVOID DAMAGE TO THE ROOTS. ALTERNATE CONSTRUCTION METHODS, SUCH AS A REINFORCED SIDEWALK, SHALL BE IMPLEMENTED AS NECESSARY.
- 5. FOR ALL TREES, CUTTING OF LARGE STRUCTURAL ROOTS LOCATED NEAR THE BASE OF THE TRUNK IS PROHIBITED. DO NOT COMPACT SOIL BENEATH TREES. NO VEHICLE SHALL BE ALLOWED TO PARK UNDER TREES. NO MATERIALS OR EQUIPMENT SHALL BE STORED BENEATH TREES. DAMAGING THE BARK WITH LAWNMOWERS, CONSTRUCTION EQUIPMENT, OR ANYTHING ELSE IS PROHIBITED. CONTRACTOR SHALL REPAIR DAMAGE TO TREES.
- 6. FAILING TO INSTALL OR MAINTAIN PROTECTION MEASURES SHALL RESULT IN A STOP WORK ORDER AND FINE OF \$500/DAY. DISTURBANCE OTHER THAN THAT ALLOWED

	TREE MITIGATION.	LETTER OF CREDIT F	·UK
	STANDARD DETAIL	CITY OF	
OATE: JAN, 2015	TREE PROTECTION		GTON ORTH CAROLINA
DRAWN BY JSR	DURING	CITY OF WILMINGTON E	NGINEERING
CHECKED BY RDG, P.E.	CONSTRUCTION	PO BOX 1810 WILMINGTON, NC 28402 (910) 341-7807)
SCALENOT TO SCALE	SHEET 1 of 2	(910) 341-7807	SD 15-09



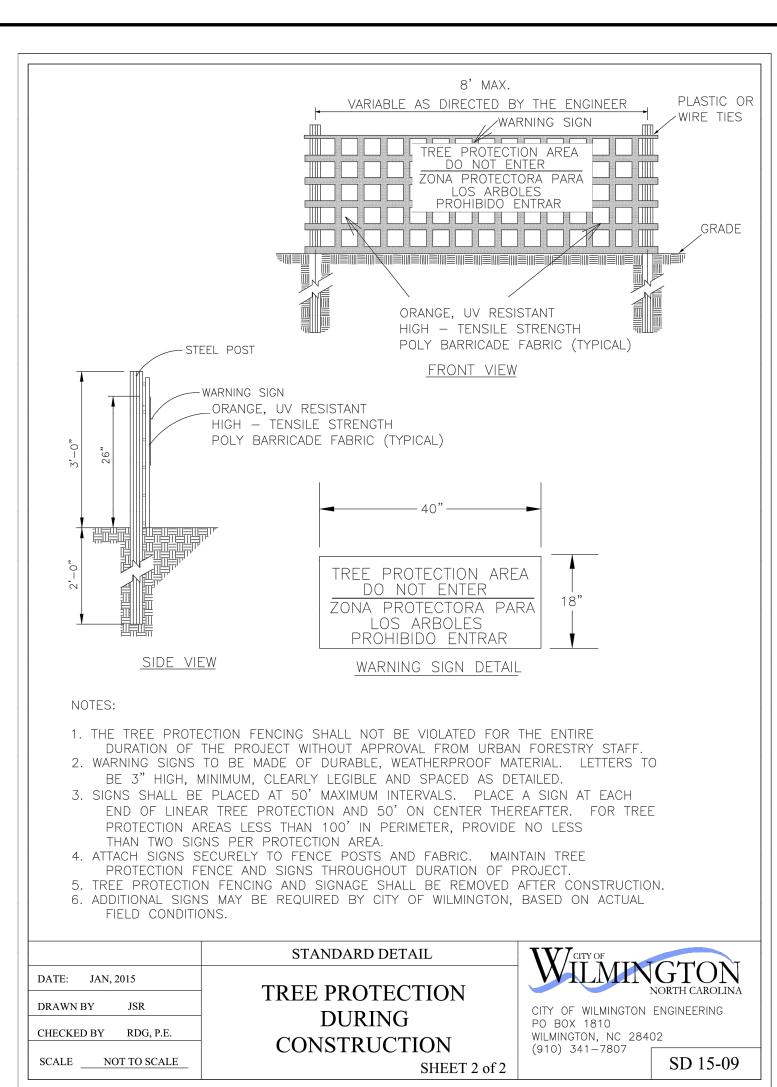

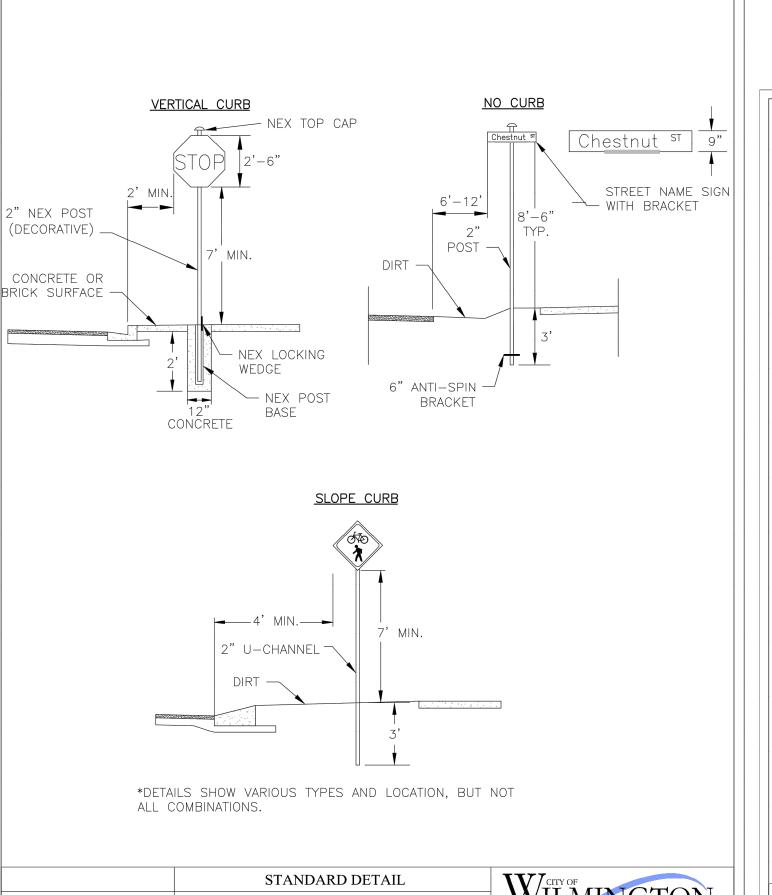

SHEET 1 of 2

SCALE NOT TO SCALE

WILMINGTON, NC 28402 (910) 341-7807 SD 15-03 SCAL



- 1. All signs shall meet the requirements of MUTCD and City Traffic Engineering in effect at the time of construction.
- 2. All Traffic Control Signs including multi-use paths shall be fabricated with 0.080 inch aluminum blanks using high intensity prismatic reflective sheeting Type IV or better. STOP signs shall be a minimum of 30"x30".
- 3. SPECIAL DESIGNATION signs by location and type shall adhere to City of Wilmington signage plan (ie. downtown, historic, cross-city trail, parks, riverfront, scenic by-way, parking, etc.) and all associated policies.
- 4. POST MOUNTED STREET NAME SIGNS shall be fabricated with 9" extruded aluminum street name sign blanks using a standard cut-out. Minimum sign length is 18" long and increasing in 6" increments to 54" maximum as dictated by the number of letters in the name. The color scheme shall be white letters on a green background without a border. Generally, in the downtown and historic areas or as designated in the City of Wilmington signage plan the background shall be blue and contain a topper.
- 5. Decorative sign posts shall consist of the NEX sign support system, 2" octagonal tube, 14 gauge, powder coated glossy black and include cap, post, base and wedge.
- 6. All other sign posts shall be u-channel posts made of galvanized steel with 8' posts 2lbs/ft or 12' posts 3lbs/ft. Galvanized NEX post may be substituted with approval from the City Signs and Markings Engineer.
- 7. OVERHEAD STREET NAME SIGNS shall be fabricated with 0.080 inch aluminum flat sign blanks 18" in height using a standard cut-out. Sign length will be dictated by the number of letters in the name. For mast-arm type traffic signal supports and other overhead support systems refer to the design plans for maximum sign length.
- 8. All sign lettering, colors and fonts shall adhere to the MUTCD in effect at the time of construction. Florescent Yellow-Green shall be used on signs, in place of Yellow, when listed as an optional color in the MUTCD. Generally, the font will be FHWA series fonts (Highway Gothic.) Other font types require prior City Signs and Markings Engineer approval .

LOCATION


- 9. Sign locations depend on the edge of road condition. Generally, signs shall be a minimum 2' from face of a vertical curb, 4' from front of slope face curb, and 6' from edge of pavement without curb. Signs shall not be located more than 12' from any of these locations.
- 10. Sign posts installed in dirt shall be buried a minimum of 36". Octagonal posts shall utilize an anti-spin device, 6" in length minimum. Sign posts installed in concrete or brick shall utilize a base cast in concrete 24" x 12" diameter.
- 11. Street name signs shall be installed 8'-6" from the ground to the bottom of the sign. Street name signs co-located with STOP signs shall be installed above the STOP sign. A 6" space shall be maintained between the STOP sign and a Street name sign that is parallel to the STOP sign face. All other signs should be mounted per MUTCD guidelines for Urban Areas.

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	STANDARD DETAIL	CITY OF	OHOLI
TE: NOVEMBER, 2011	STREET SIGNS		GTON NORTH CAROLINA
AWN BY JSR	AND LOCATION	CITY OF WILMINGTON	ENGINEERING
ECKED BY BDR, P.E.	111,2 20 011101,	PO BOX 1810 WILMINGTON, NC 2840	02
ALE NOT TO SCALE	SHEET 2 of 2	(910) 341–7807	SD 15-03
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LICENSE # C-2710 **ENGINEERING** LAND PLANNING COMMERCIAL / RESIDENTIAL

P.O. BOX 4041 WILMINGTON, NC 28406 (910) 791–4441



DATE: 7-12-17

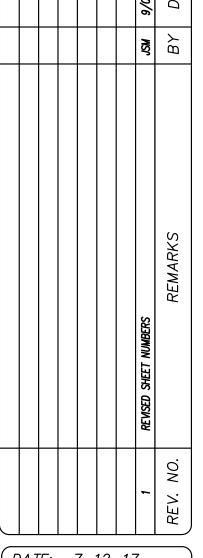HORZ. SCALE: N/A VERT. SCALE: N/A DRAWN BY: RLW

CHECKED BY: HSR PROJECT NO.: 17-0398